
WILCOR HOMES SPRING LAKE RANCH THE ASPEN MIRRORED 1575 sf BUNGALOW

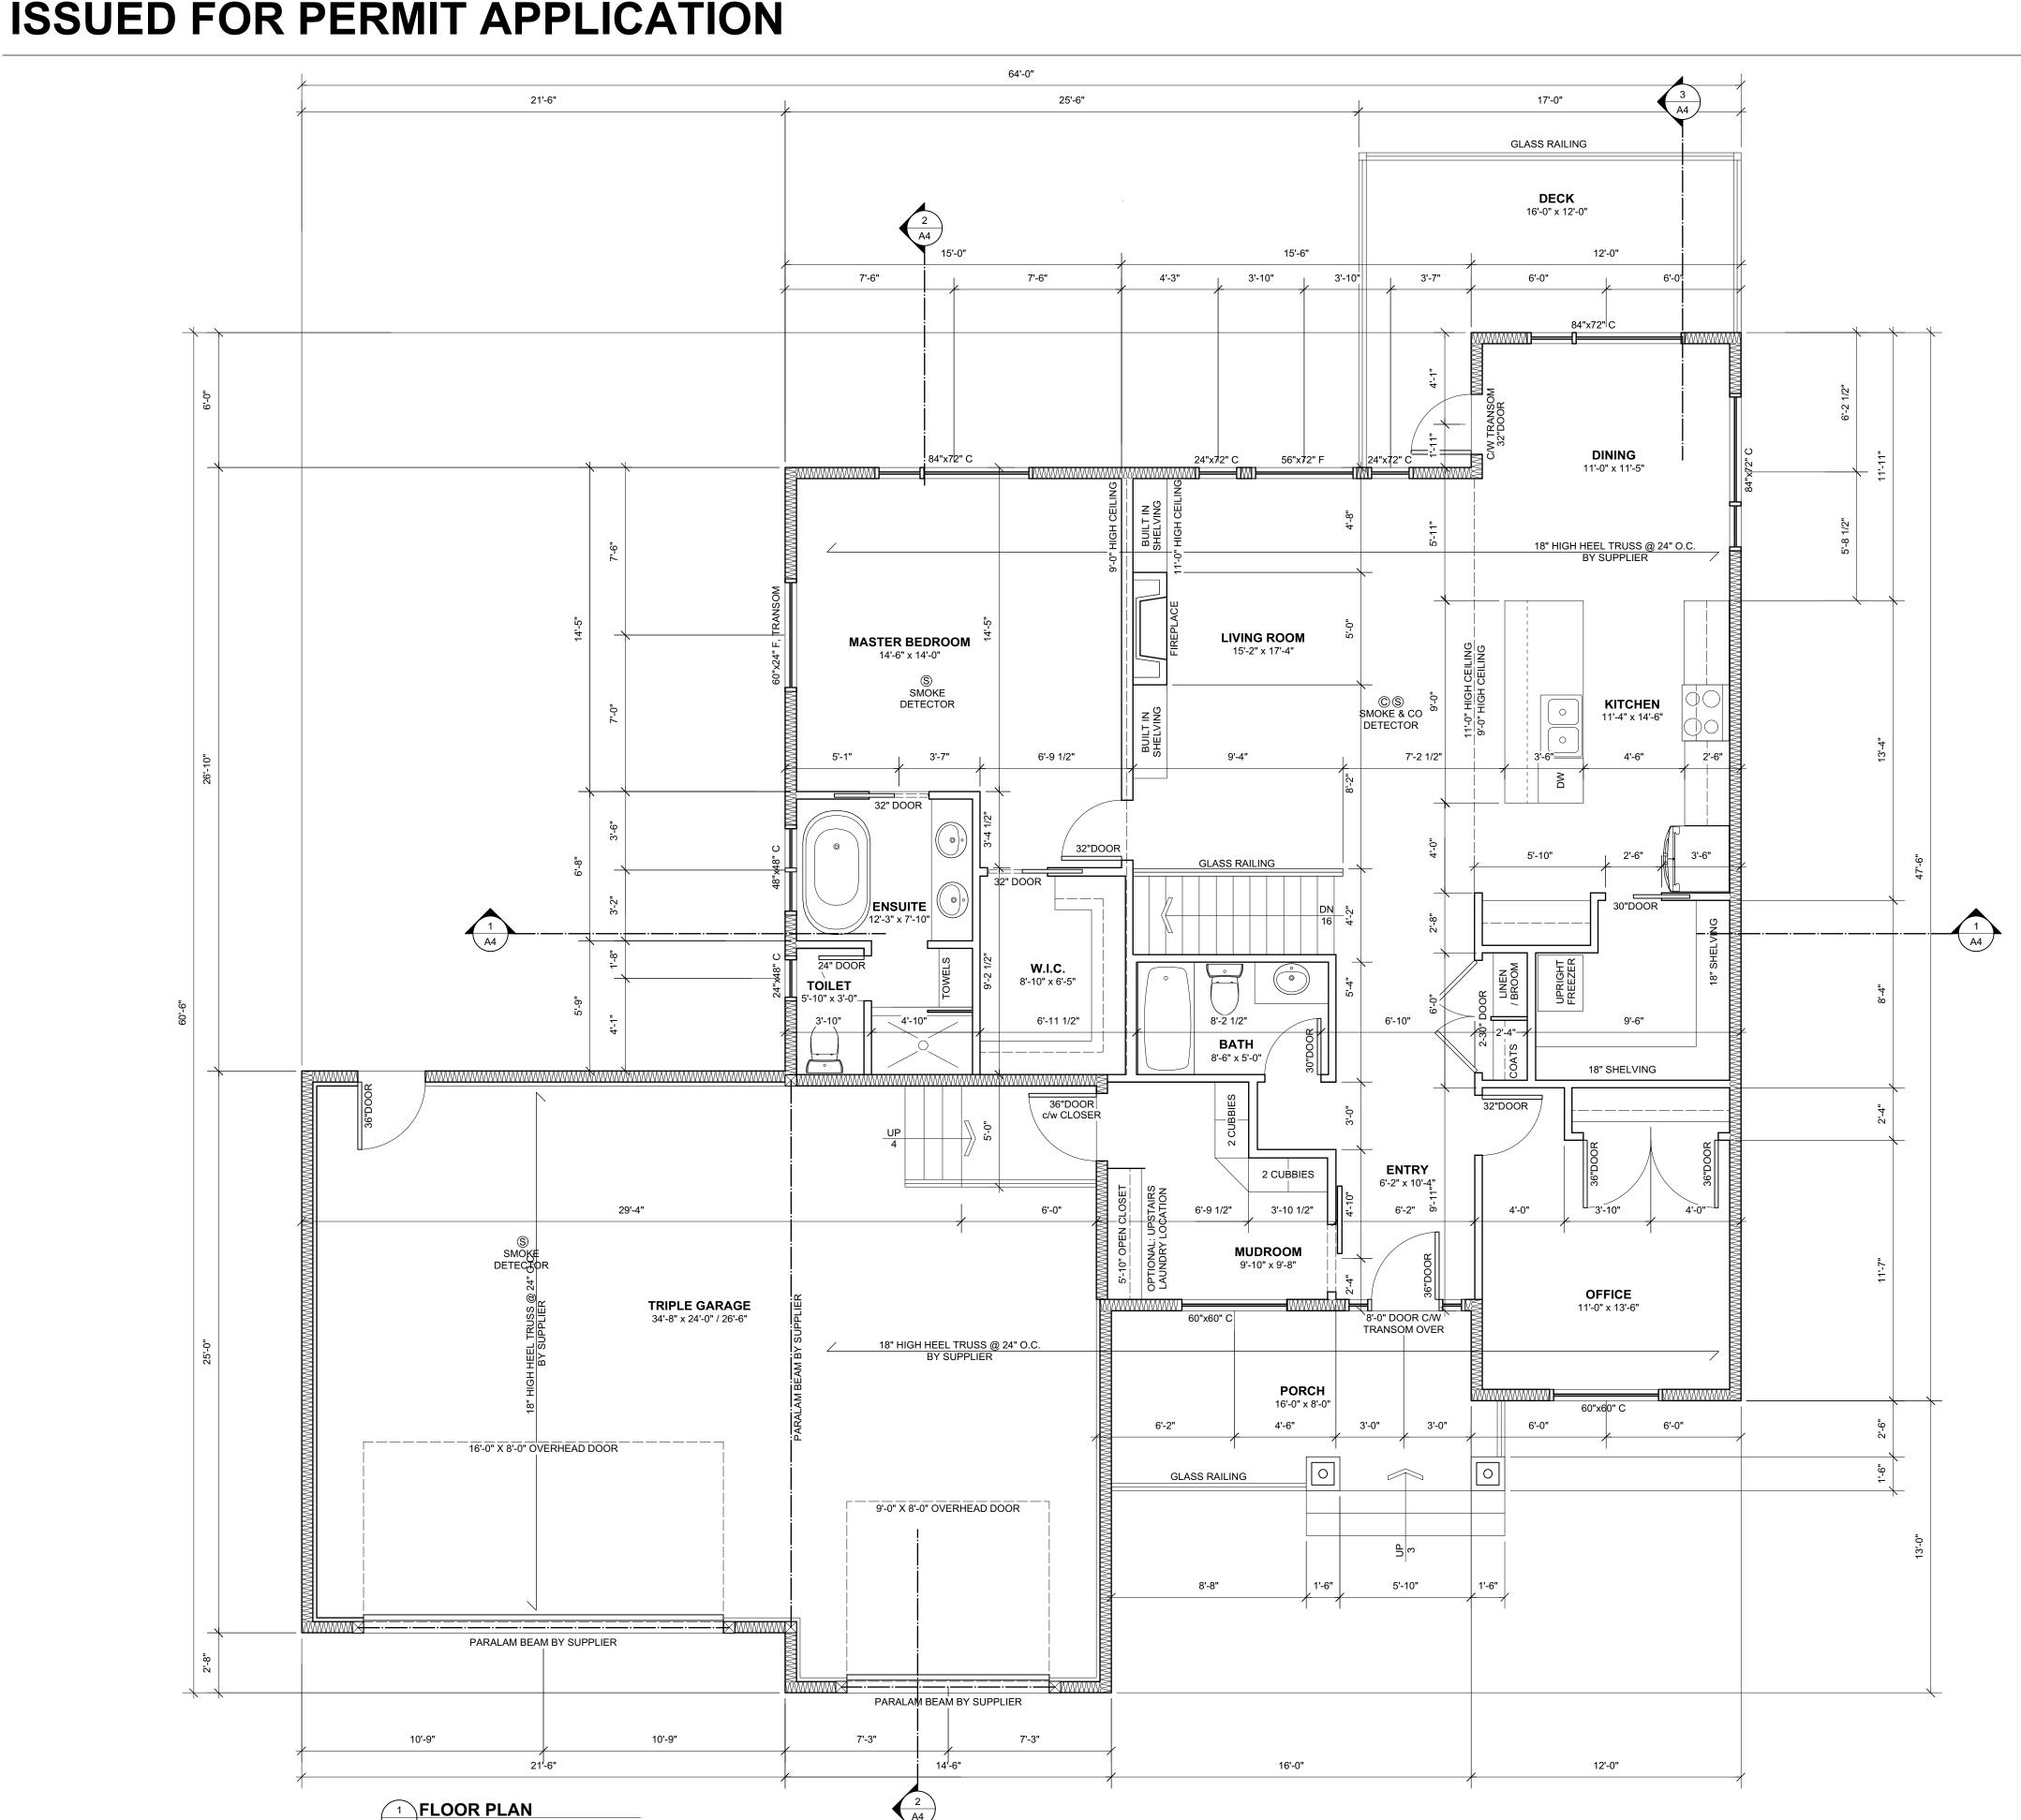

-ALL SCOPES OF WORK SHALL MEET THE ALBERTA BUILDING CODE (LATEST EDITION).

THE CONTRACTOR/OWNER SHALL BE RESPONSIBLE FOR OBTAINING ALL REQUIRED PERMITS REQUIRED FOR COMPLETING PROJECT.

-OWNER SHALL ENSURE QUALITY OF WORK MEETS HIS/HER STANDARDS

-THE CONTRACTOR/OWNER SHALL BE RESPONSIBLE FOR OBTAINING ANY STRUCTURAL MECHANICAL, ELECTRICAL DRAWINGS OR APPROVALS NEEDED TO COMPLETE THE PROJECT OR FOR OBTAINING PERMITS.

-THE CONTRACTOR/OWNER SHALL BE RESPONSIBLE FOR OBTAINING SOILS REPORT AS

-THE CONTRACTOR/OWNER SHALL ENSURE ALL ASPECTS OF THE REQUIRED BYLAWS ARE MET

-ALL UTILITY HOOKUPS SHALL CONFORM WITH ALL RELEVANT REGULATIONS.

THE DRAWINGS AND ENSURE ALL ASPECTS OF THE A.B.C. ARE MET. ALL SIZES & DIMENSIONS TO BE CONFIRMED BY GENERAL CONTRACTOR. ANY DISCREPANCIES TO BE REPORTED TO THIS OFFICE AND CLARIFICATION AGREED UPON BEFORE PROCEEDING

-ALL CONTRACTORS SHALL CARRY LIABILITY INSURANCE ACCEPTABLE TO THE OWNER.

-ALL LABOUR LAWS AND SAFETY STANDARDS MUST BE ADHERED TO

-THE CONTRACTOR/OWNER SHALL HIRE AN ALBERTA LAND SURVEYOR FOR THE PURPOSE OF LOCATING THE PROPOSED BUILDING ON SITE AND ESTABLISHING GRADES.

ACCORDANCE WITH THE ALBERTA BUILDING CODE. GAS FIREPLACES AND FURNACES ARE TO BE VENTED DIRECTLY OUTSIDE AND DUCT IS TO BE INSULATED THROUGH UNHEATED SPACE. EXHAUST VENT IS TO BE 1.0m FROM ANY FIXED WINDOW AND 2.0m FROM ANY OPENING WINDOW.

ELEMENTS (E.G. TUBS, FIXTURES, LIGHTS, ETC.)

ACCUMULATE AT OR NEAR THE BUILDING.

ABOVE FINISHED GRADE AND ARE TO BE REINFORCED WITH 2 ROWS OF 2-10M REBAR

CONFIRM WITH ENGINEER

-SECURE THE FLOOR SYSTEM TO CONCRETE FOUNDATION WALL WITH 1/2" ANCHOR

-FOOTINGS SHALL REST ON UNDISTURBED SOIL AND HAVE MIN 5'-0" OF FROST PROTECTION.

JOISTS / TRUSSES SHALL BE PROVIDED AND SHALL NOTE ANY EXTRA FOOTING. BEAMS. COLUMNS, JOISTS, ETC. TO ENSURE CONSTRUCTION MEETS CODE. ANY CHANGE IN FOOTING SIZE, QUANTITY. AND LOCATION AS REQUIRED BY JOIST SUPPLIER TO BE NOTED BY CONTRACTOR/OWNER. CONTRACTOR/OWNER TO ENSURE MODIFICATIONS ARE

-FOR DIMENSIONAL LUMBER, DOUBLE FRAMING UNDER ALL PARALLEL PARTITIONS

-BUILT-UP BEAMS SHALL ONLY HAVE SPLICES IN ALTERNATE POINT PAST A POST

-FIRE STOPS ARE TO BE PROVIDED AT ALL CONCEALED SPACES AT FLOOR, CEILING AND ROOF LEVELS INCLUDING THE SPACE BETWEEN THE CHIMNEY FLUE AND SHAFT

-PROVIDE BUILT-UP POSTS OF A WIDTH EQUAL TO THE WIDTH OF BEAM WHERE FRAMED INTO INTERIOR OR EXTERIOR WALLS.

-WINDOW SIZES ARE SHOWN ON BUILDING ELEVATIONS AND ARE SHOWN BY NOMINAL SIZE. OWNER TO VERIFY STYLE, TYPE, AND EXACT ROUGH OPENING SIZE PRIOR TO CONSTRUCTION.

-ALL FRAMING SURROUNDING TUBS, SHOWER, ETC. AS SELECTED BY OWNER SHALL BE

-ALL STRUCTURAL LINTELS TO BE 3-2"X10" SPR (UNLESS OTHERWISE SPECIFIED).

-ENSURE NO PLUMBING PIPES ARE PLACED IN EXTERIOR WALLS. VERIFY ON SITE, EXACT

-PROVIDE CLOSER & WEATHERSTRIPPING ON DOOR BETWEEN GARAGE AND LIVING AREA (IF APPLICABLE). ALL WALLS/CEILINGS BETWEEN GARAGE AND LIVING SPACE TO BE CONSTRUCTED TO PROVIDE AN EFFECTIVE BARRIER TO GAS AND EXHAUST FUMES

AND 3'-0" ABOVE ANY CONTACTING ROOF SURFACE.

-USE 1/2" CEILING DRYWALL OR 5/8" DRYWALL WHERE TRUSS SPACING IS

-A SMOKE ALARM INSTALLED BY PERMANENT CONNECTIONS TO AN ELECTRICAL CIRCUIT IS TO BE PROVIDED IN EVERY BEDROOM AND BETWEEN ALL SLEEPING AREAS AND THE REMAINDER OF THE HOUSE.

-PLUMBING ACCESS OF 16"X20" TO BE PROVIDED FOR TUBS AND SHOWERS

PROVIDE FRESH AIR INTAKES FOR FURNACES AND FIREPLACE.

GENERAL NOTES

REQUIRED AND ENSURING FOOTINGS/FOUNDATIONS AS DRAWN ARE SUFFICIENT

-PRIOR TO CONSTRUCTION, ALL CONTRACTORS SHALL FAMILIARIZE THEMSELVES WITH

-ANY FUEL FIRED APPLIANCE AS CHOSEN BY THE OWNER SHALL BE INSTALLED IN

-THE OWNER SHALL BE RESPONSIBLE FOR THE SELECTION OF ALL INTERIOR DESIGN

-THE BUILDING SITE SHALL BE GRADED SO THAT SURFACE WATER SHALL NOT

-CONCRETE FOUNDATION WALLS TO BE 8" THICK AND EXTEND A MINIMUM OF 8" -CONCRETE FOUNDATION WALLS SHALL BE DAMP-PROOFED WITH HEAVY COAT OF

-BASEMENT WINDOWS SHALL BE REINFORCED WITH 2-10M VERTICAL & HORIZONTAL REBAR AROUND THE PERIMETER OF THE WINDOW AND PROJECT 12" BEYOND.

-ALL STRUTURAL CONCRETE SHALL BE NOT LESS THAN 32Mpa.

BOLTS @ 4'-0" O.C. MAX OR EQUAL

-END BEARING OF JOISTS AND RAFTERS SHALL NOT BE LESS THAN 1 1/2"

-JOIST AND TRUSS LAYOUT/SIZES SHALL BE VERIFIED BY SUPPLIER. SHOP DRAWINGS OF

WHERE IT PASSES THROUGH A FLOOR OR CEILING.

-OWNER TO VERIFY DIRECTION OF OPENERS

-ALL BATHROOM WALLS TO BE INSULATED WITH BATT INSULATION FOR NOISE ATTENUATION. OWNER TO INSTRUCT FOR OTHER INSULATED WALLS.

-INCREASE WIDTH OF WALL TO CONCEAL WIDTH OF DROP BEAM IF APPLICABLE. VERIFY

LOCATION OF REQUIRED PLUMBING PIPES.

-AT THE INTERSECTION OF ROOFS, PROVIDE SHEET METAL FLASHING OF GALVANIZED STEEL OR OTHER ACCEPTABLE MATERIAL.

EAVE PROTECTION OF AT LEAST 6 MIL POLYETHYLENE OR OTHER ACCEPTABLE MATERIAL IS TO BE PROVIDED AND IS TO EXTEND FROM THE EDGE OF THE ROOF AT LEAST 36" UP THE ROOF

-CHIMNEY HEIGHT TO BE 2'-0" ABOVE ANY ROOF SURFACE WITHIN 10'-0"

GREATER THAN 16" O.C.

-NON HARDENING CAULKING COMPOUND TO BE USED AROUND ALL EXTERIOR OPENINGS.

-HEATING CONTRACTORS TO DESIGN AND INSTALL HEATING SYSTEMS.

CONSTRUCTION ASSEMBLIES FOUNDATION WALL (RSI 3.46 REQ'D, REFER TO TABLE

A-9.36.2.1 (C) & TABLE 9.36.2.4.1 (D

0.081 8" CONCRETE WALL 1.68 2" XPS TYPE 3 INSULATION 1.64 2X4 STUDS @ 16" O.C. C/W

6 MIL POLY VAPOUR BARRIER

0.08 1/2" GYPSUM BOARD 0.12 INTERIOR AIR FILM 3.60 EFFECTIVE VALUE

(RSI 3.08 REQ'D, REFER TO TABLE A-9.36.2.1 (B) & TABLE 9.36.2.4.1 (D)

0.03 EXTERIOR AIR FILM

0.108 7/16" OSB SHEATHING 2.66 2x6 SPF STUDS @ 16" O.C.

R-24 BATT NSULATION 6 MIL POLY VAPOUR BARRIER 0.08 1/2" GYPSLIM BOARD 0.12 INTERIOR AIR FILM (H.E. HORIZONTAL)

3.11 EFFECTIVE VALUE

RIM BOARD (RSI 3.08 REQ'D, REFER TO TABLE A-9.36.2.1 (B) & TABLE 9.36.2.6(2)

0.03 EXTERIOR AIR FILM 0.11 CLADDING SHEATHING PAPER 0.108 3/8" OSB SHEATHING

6 MIL POLY SHEET 0.26 1 1/4" ENGINEERED RIM JOIST 3.41 11 7/8" TJI. FLOOR JOISTS @ 16" O.C. R20 BATT OR SPRAY INSULATION

0.12 INTERIOR AIR FILM (H.F. HORIZONTAL) 4.038 EFFECTIVE VALUE INTERIOR WALL
NO RSI REQUIREMENT

1/2" GYPSUM BOARD 2X4 STUDS @ 16" O.C. INSULATION AS PER OWNER PROVIDE 2X6 STUDS WHERE REQ'D FOR PLUMBING 1/2" GYPSUM BOARD

GARAGE TO HOUSE WALL (RSL3 08 REO'D REFER TO TABLE

A-9.36.2.1 (B) & TABLE 9.36.2.4.1 (D)

0.12 INTERIOR AIR FILM 0.10 5/8" FIRE RATED GYPSUM BOARD 0.108 7/6" OSB SHEATHING 2.66 2X6 STUDS @ 16" O.C.

c/w R-24 BATT INSULATION 6 MIL POLY VAPOUR BARRIER 0.08 1/2" GYPSUM BOARD 0.12 INTERIOR AIR FILM

3.19 EFFECTIVE VALUE FLOOR ASSEMBLY NO RSI REQUIREMENT FINISH FLOORING AS PER OWNER

3/8" T&G OSB UNDERLAY WHERE REQ'D 3/4" T&G FLOOR SHEATHING 11 7/8" PREMANUFACTURED FLOOR JOISTS @ 16" O.C. 1/2" PAINTED GYPSUM BOARD **BASEMENT SLAB ASSEMBLY**

6 MIL POLY VAPOUR BARRIER COMPACTED GRANULAR FILL SEAL ALL SLAB PENETRATIONS

3 1/2" CONCRETE SLAB C/W REINFORCING AS REQUIRED

AND PERIMETER OF SLAB ROOF ASSEMBLY (RSI 10.43 REQ'D, REFER TO TABLE À-9.36.2.6(1b)

0.03 EXTERIOR AIR FILM **ASPHALT SHINGLES**

7.62 7/16" EXT. ROOF SHEATHING AS PER 2.84 TRUSS MANUFACTURER 12" LOOSE FILL CELLULOSE (R42) 2x6 BOTTOM CHORD @ 26" O.C. c/w 5.5" LOOSE FILL CELLULOSE (R19) 0.08 6 MIL POLY VAPOUR BARRIER

0.11 1/2" CEILING GYPSUM BOARD INTERIOR AIR FILM (H.F. UP)






THE ASPEN MIRRORED 1575 sf BUNGALOW with 922 sf GARAGE

BASEMENT FLOOR PLAN

1812 **PROJECT NUMBER** 1/4" = 1'-0" SCALE: JULY 25, 2018

FOR PERMIT APPLICATION

DRAWING NUMBER

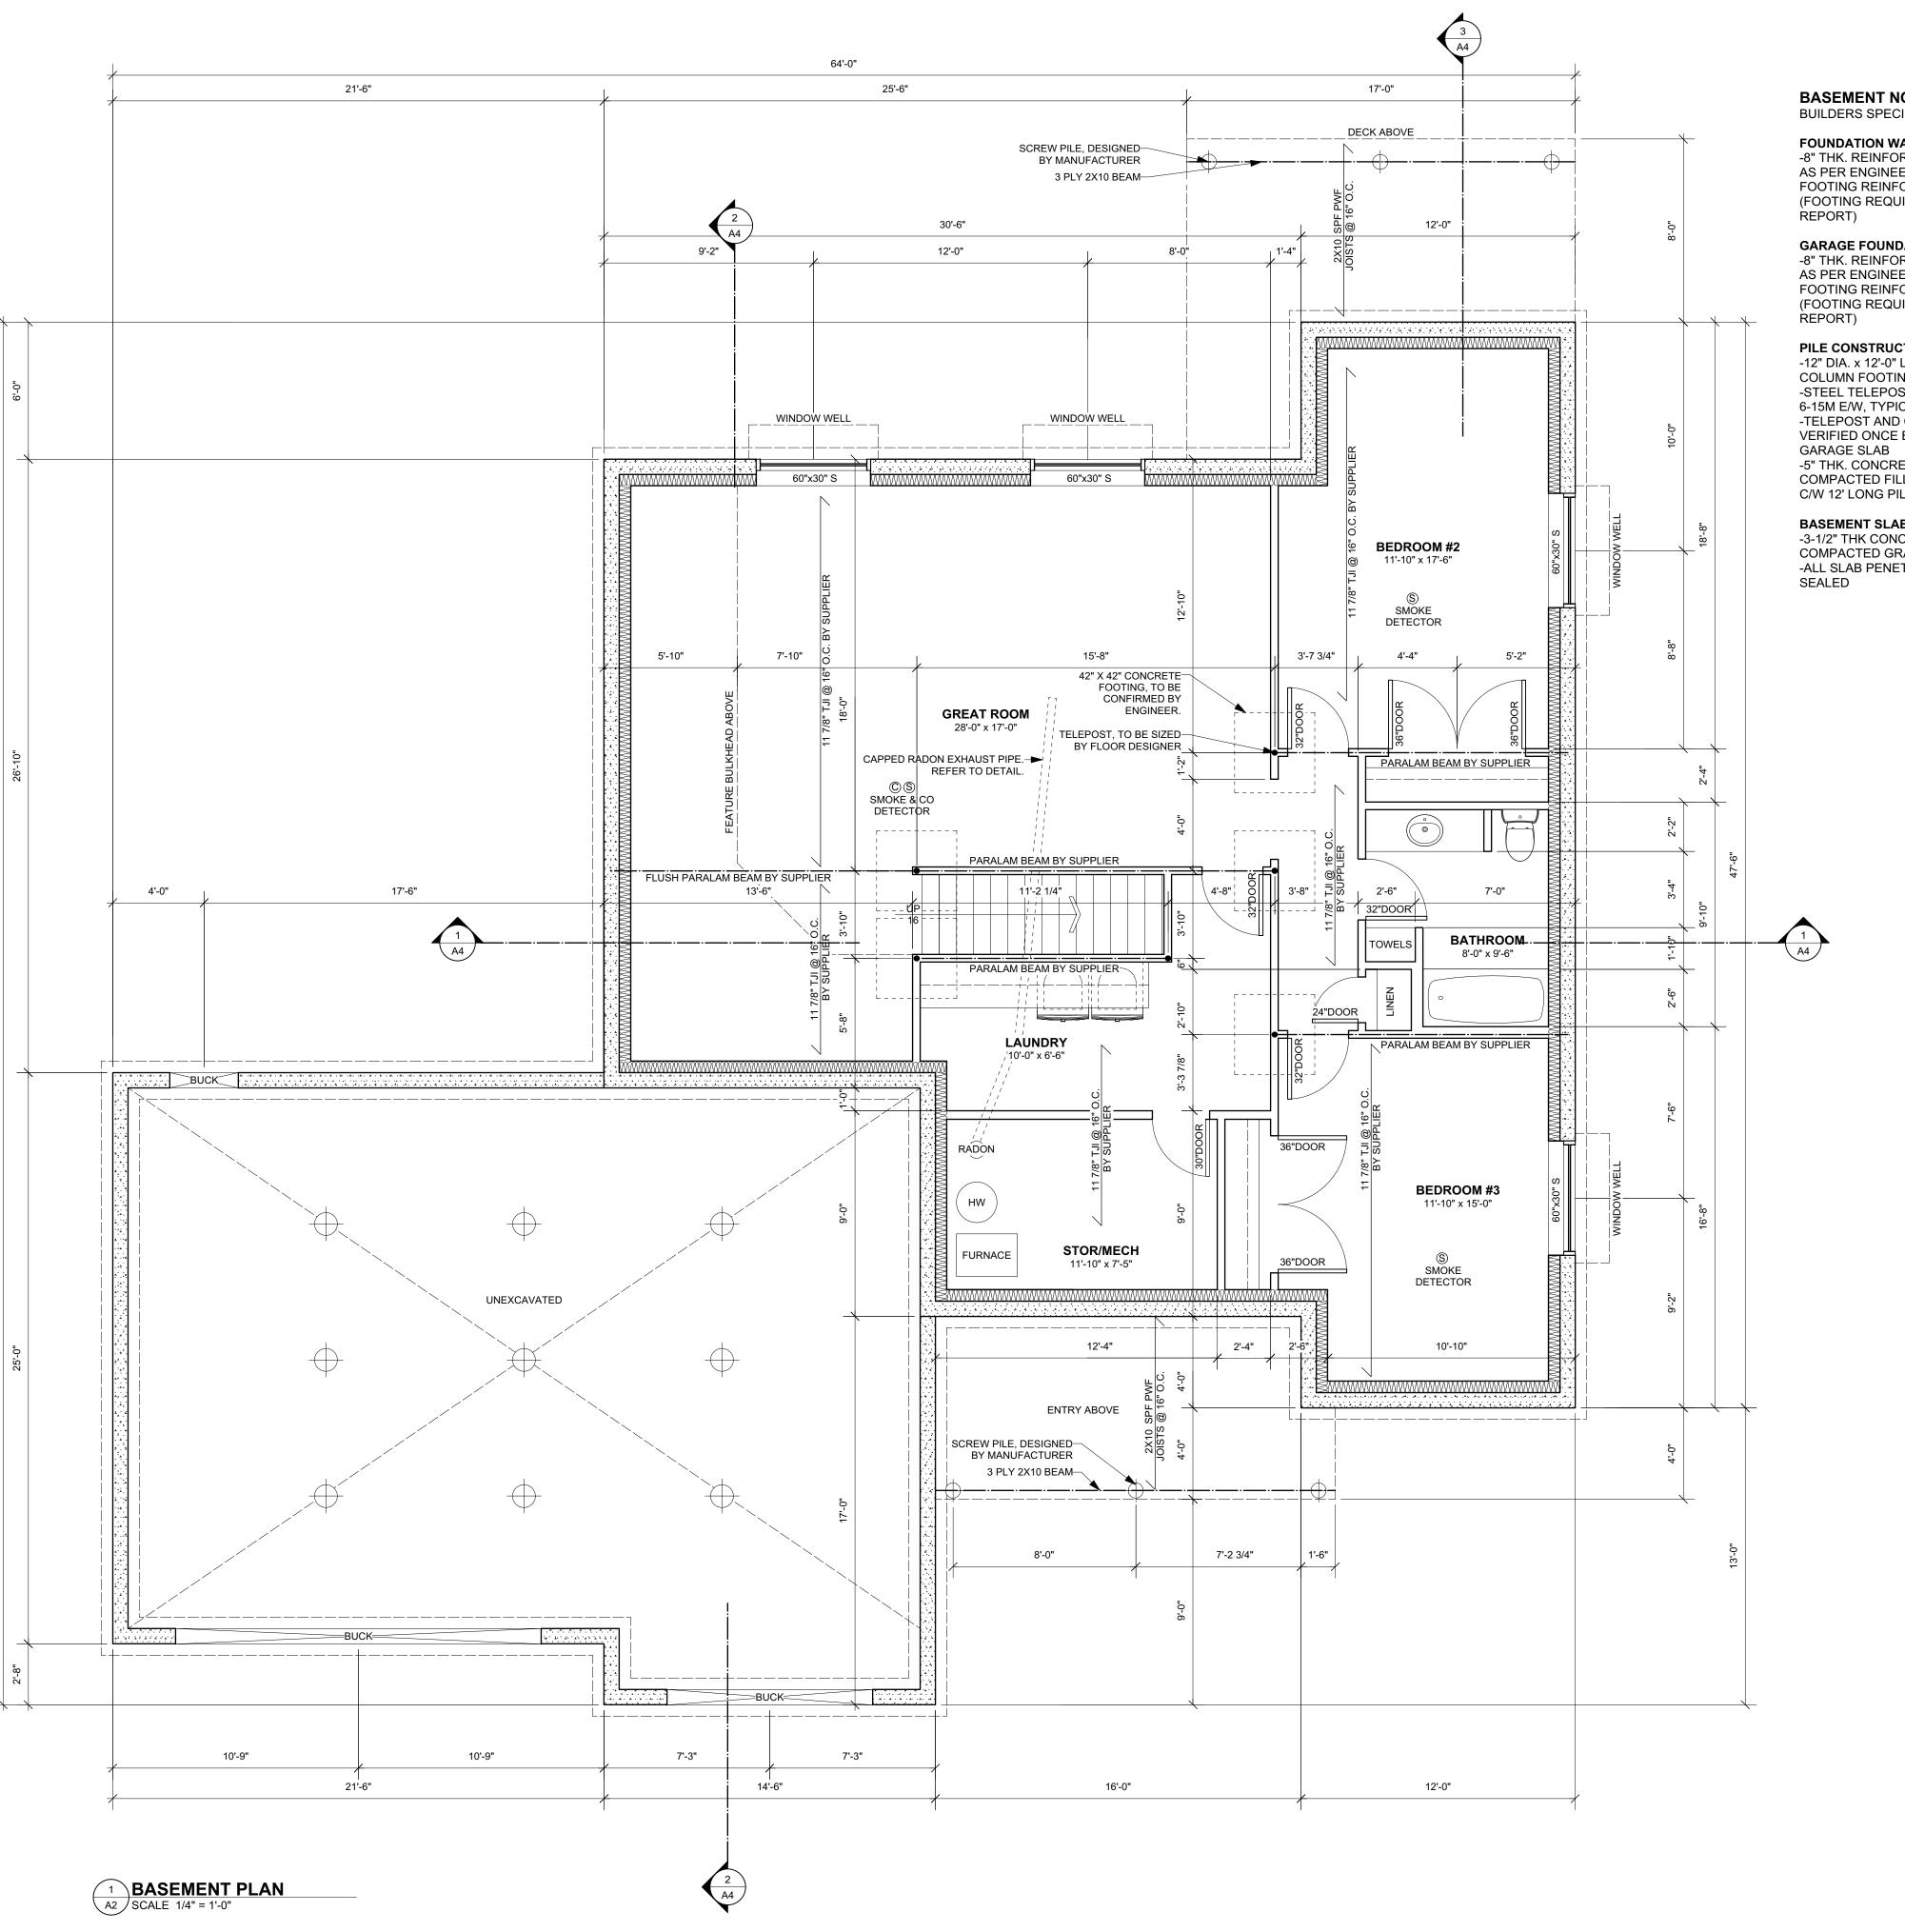

BASEMENT NOTES:

BUILDERS SPECIFICATION MAY GOVERN OVER THESE NOTES:

FOUNDATION WALL CONSTRUCTION -8" THK. REINFORCED CONCRETE WALL AS PER ENGINEERED DESIGN ON 20"x10" FOOTING REINFORCED WITH 2-10M CONT. (TYP.) (FOOTING REQUIREMENTS TO BE VERIFIED BY SOILS

GARAGE FOUNDATION WALL CONSTRUCTION -8" THK. REINFORCED CONCRETE WALL AS PER ENGINEERED DESIGN ON 20"x10" FOOTING REINFORCED WITH 2-10M CONT. (TYP.) (FOOTING REQUIREMENTS TO BE VERIFIED BY SOILS

PILE CONSTRUCTION

-12" DIA. x 12'-0" LONG CONC. PILES **COLUMN FOOTINGS** -STEEL TELEPOST ON 42" SQ.x10" THK. FOOTING R/W 6-15M E/W, TYPICAL -TELEPOST AND CONCRETE PAD SIZES TO BE VERIFIED ONCE BEAM LOADS ARE KNOWN -5" THK. CONCRETE SLAB R/W 10M @ 18" O/C E.W. ON COMPACTED FILL MATERIAL (TYP.) C/W 12' LONG PILES R/W 4-10M VERTICAL

BASEMENT SLAB

-3-1/2" THK CONC. ON AIR/SOIL GAS BARRIER ON COMPACTED GRANULAR FILL(REINFORCE IF REQUIRED) -ALL SLAB PENETRATIONS AND PERIMETER TO BE

GENERAL NOTES:

WEEPING TILE TO BE INSTALLED AROUND ENTIRE

-PROVIDE GALVANIZED WINDOW WELLS TO SUIT GRADE. FILL WELLS WITH FILTER FABIC UNDER 6" OF GRAVEL. PROVIDE PVC PIPE CONNECTION TO WEEPING TILE. MODIFY MAIN FLOOR ELEVATION AS REQ'D. VERIFY CONDITION ON SITE.

-VERIFY BEAM AND JOIST SIZES WITH MANUF. (TYP.)

-PROVIDE BEAM POCKETS AS NEEDED FOR BEAM

-JOIST AND BEAM LAYOUT TO BE CONFIRMED BY SUPPLIER OF JOISTS AND BEAMS.

PANEL LOCATIONS TO BE CONFIRMED ON SITE

-PROVIDE CONTINUOUS FILTER FABRIC SOCK AROUND 4" PERIMETER OF STRIP FOOTING WITH MIN. 12" GRAVEL COVER AND TIED TO DRAINAGE SYSTEM ACCORDING TO LOCAL BYLAWS (TYP.)

-PROVIDE JOIST BLOCKING AS PER JOIST MANUF. (TYP.)

-PROVIDE DECK NAILER AS REQUIRED

LAYOUT. VERIFY LOCATION AND SIZES WITH JOIST LAYOUT DRAWINGS.

-INSULATE, SEAL AND PROVIDE PREFINISHED METAL SOFFIT TO ALL CANTILEVERS

-SUMP PIT, FURNACE, HOT WATER TANK, ELECTRICAL

CONSTRUCTION ASSEMBLIES

FOUNDATION WALL
(RSI 3.46 REQ'D, REFER TO TABLE A-9.36.2.1 (C) & TABLE 9.36.2.4.1 (D) RSI ITEM 0.081 8" CONCRETE WALL 1.68 2" XPS TYPE 3 INSULATION

1.64 2X4 STUDS @ 16" O.C. C/W

R-12 BATT INSULATION

6 MIL POLY VAPOUR BARRIER

0.12 INTERIOR AIR FILM 3.60 EFFECTIVE VALUE

0.08 1/2" GYPSUM BOARD

EXTERIOR WALL
(RSI 3.08 REQ'D, REFER TO TABLE

A-9.36.2.1 (B) & TABLE 9.36.2.4.1 (D) RSI ITEM 0.03 EXTERIOR AIR FILM 0.11 CLADDING

SHEATHING PAPER 0.108 7/16" OSB SHEATHING 2.66 2x6 SPF STUDS @ 16" O.C.

R-24 BATT NSULATION 6 MIL POLY VAPOUR BARRIER 0.08 1/2" GYPSUM BOARD 0.12 INTERIOR AIR FILM (H.E. HORIZONTAL)

3.11 EFFECTIVE VALUE RIM BOARD (RSI 3.08 REQ'D, REFER TO TABLE

A-9.36.2.1 (B) & TABLE 9.36.2.6(2)

RSI ITEM 0.03 EXTERIOR AIR FILM 0.11 CLADDING

SHEATHING PAPER 0.108 3/8" OSB SHEATHING 6 MIL POLY SHEET

0.26 1 1/4" ENGINEERED RIM JOIST 3.41 11 7/8" TJI. FLOOR JOISTS @ 16" O.C. R20 BATT OR SPRAY INSULATION 0.12 INTERIOR AIR FILM (H.F. HORIZONTAL)

4.038 EFFECTIVE VALUE INTERIOR WALL
NO RSI REQUIREMENT

1/2" GYPSUM BOARD 2X4 STUDS @ 16" O.C. INSULATION AS PER OWNER PROVIDE 2X6 STUDS WHERE REQ'D FOR PLUMBING

GARAGE TO HOUSE WALL
(RSI 3.08 REQ'D, REFER TO TABLE A-9.36.2.1 (B) & TABLE 9.36.2.4.1 (D)

1/2" GYPSUM BOARD

0.12 INTERIOR AIR FILM

0.10 5/8" FIRE RATED GYPSUM BOARD 0.108 7/6" OSB SHEATHING 2.66 2X6 STUDS @ 16" O.C.

c/w R-24 BATT INSULATION 6 MIL POLY VAPOUR BARRIER 0.08 1/2" GYPSUM BOARD 0.12 INTERIOR AIR FILM

3.19 EFFECTIVE VALUE FLOOR ASSEMBLY
NO RSI REQUIREMENT

3/8" T&G OSB UNDERLAY WHERE REQ'D 3/4" T&G FLOOR SHEATHING 11 7/8" PREMANUFACTURED FLOOR JOISTS @ 16" O.C. 1/2" PAINTED GYPSUM BOARD BASEMENT SLAB ASSEMBLY
NO RSI REQUIREMENT

FINISH FLOORING AS PER OWNER

FINISH FLOORING AS PER OWNER 3 1/2" CONCRETE SLAB C/W

REINFORCING AS REQUIRED 6 MIL POLY VAPOUR BARRIER COMPACTED GRANULAR FILL SEAL ALL SLAB PENETRATIONS AND PERIMETER OF SLAB

ROOF ASSEMBLY
(RSI 10.43 REQ'D, REFER TO TABLE A-9.36.2.6(1b)

0.03 EXTERIOR AIR FILM ASPHALT SHINGLES UNDERLAYMENT, EAVE, VALLEY

PROTECTION 7.62 7/16" EXT. ROOF SHEATHING AS PER 2.84 TRUSS MANUFACTURER 12" LOOSE FILL CELLULOSE (R42) 2x6 BOTTOM CHORD @ 26" O.C. c/w 5.5" LOOSE FILL CELLULOSE (R19)

0.08 6 MIL POLY VAPOUR BARRIER 0.11 1/2" CEILING GYPSUM BOARD INTERIOR AIR FILM (H.F. UP) 10.68 EFFECTIVE RSI VALUE

FOWLER

17 Fleetwood Cr. St. Albert, AB, T8N 1R4






THE ASPEN MIRRORED 1575 sf BUNGALOW with 922 sf GARAGE


BASEMENT FLOOR PLAN

FOR PERMIT APPLICATION


1812 PROJECT NUMBER: 1/4" = 1'-0" JULY 25, 2018

DRAWING NUMBER

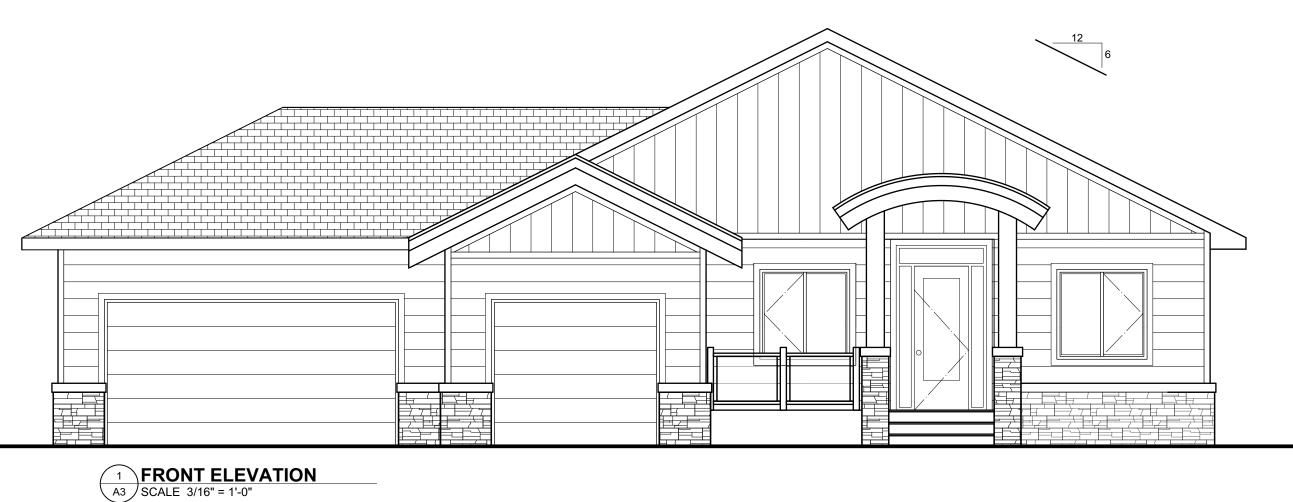


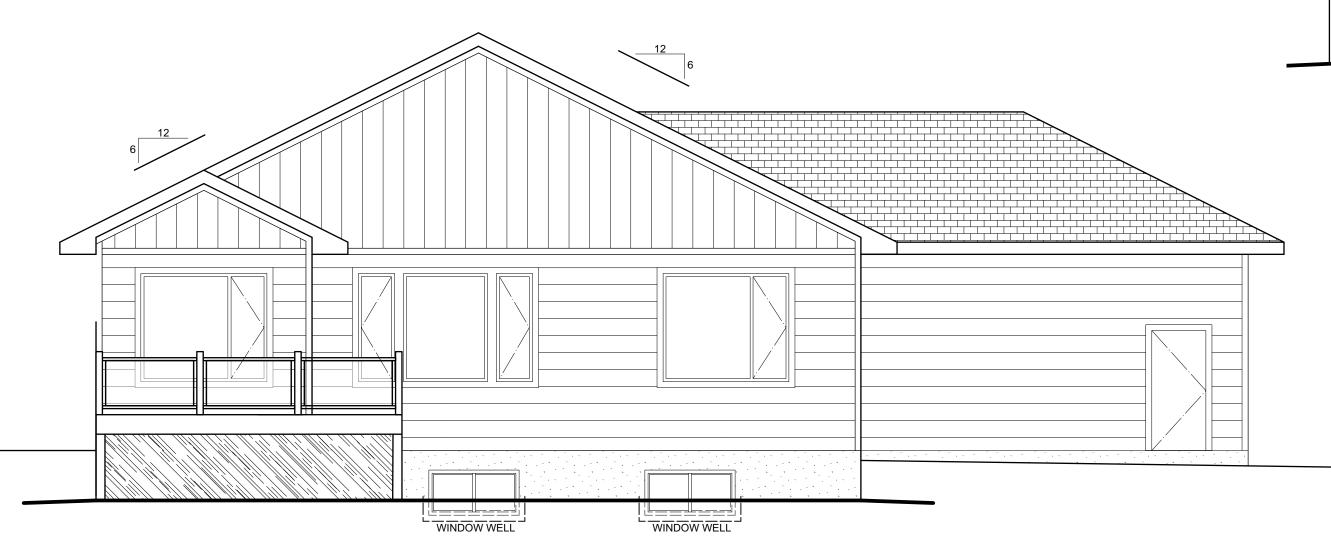

3 REAR ELEVATION
A3 SCALE 3/16" = 1'-0"

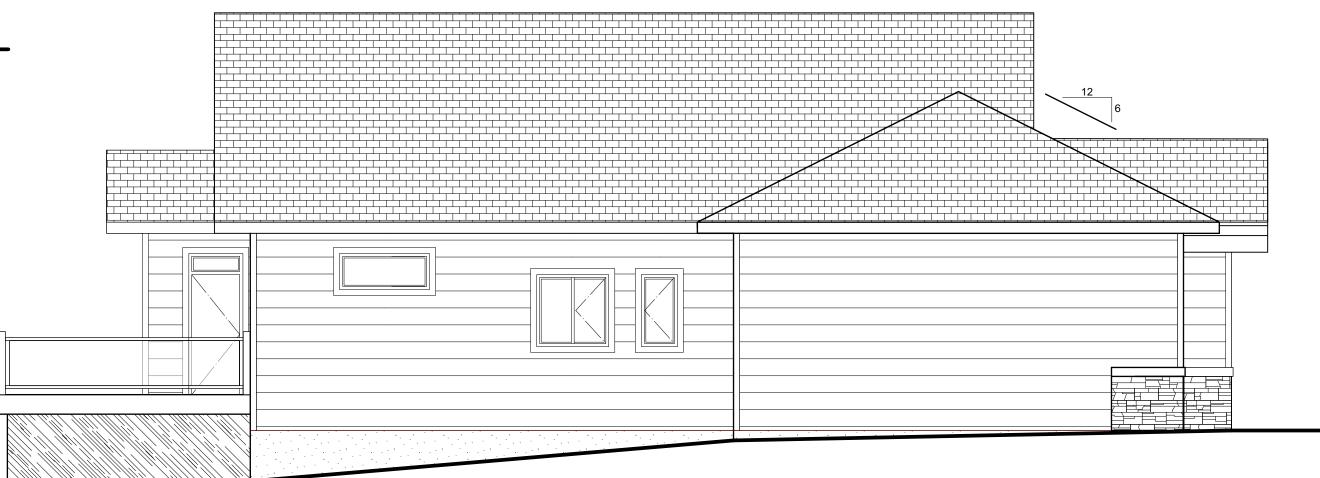

2 LEFT ELEVATION
A3 SCALE 3/16" = 1'-0"

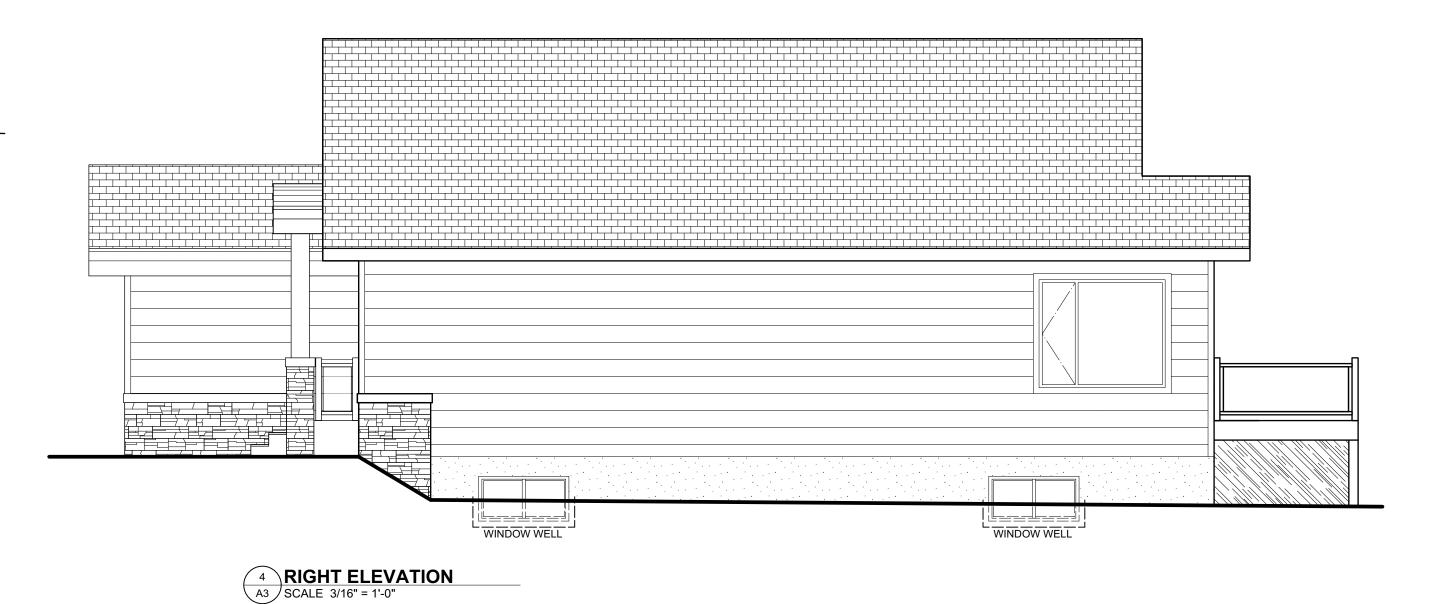

CONSTRUCTION ASSEMBLIES FOUNDATION WALL
(RSI 3.46 REQ'D, REFER TO TABLE
A-9.36.2.1 (C) & TABLE 9.36.2.4.1 (D)

RSI ITEM 0.081 8" CONCRETE WALL

1.68 2" XPS TYPE 3 INSULATION 1.64 2X4 STUDS @ 16" O.C. C/W R-12 BATT INSULATION 6 MIL POLY VAPOUR BARRIER 0.08 1/2" GYPSUM BOARD 0.12 INTERIOR AIR FILM

3.60 EFFECTIVE VALUE EXTERIOR WALL
(RSI 3.08 REQ'D, REFER TO TABLE

A-9.36.2.1 (B) & TABLE 9.36.2.4.1 (D) RSI ITEM 0.03 EXTERIOR AIR FILM

0.11 CLADDING SHEATHING PAPER 0.108 7/16" OSB SHEATHING 2.66 2x6 SPF STUDS @ 16" O.C. R-24 BATT NSULATION

6 MIL POLY VAPOUR BARRIER

1.08 1/2" GYPSUM BOARD

1.12 INTERIOR AIR FILM (H.E. HORIZONTAL)

3.11 EFFECTIVE VALUE RIM BOARD
(RSI 3.08 REQ'D, REFER TO TABLE A-9.36.2.1 (B) & TABLE 9.36.2.6(2)

RSI ITEM

0.03 EXTERIOR AIR FILM 0.11 CLADDING SHEATHING PAPER 0.108 3/8" OSB SHEATHING 6 MIL POLY SHEET 0.26 1 1/4" ENGINEERED RIM JOIST

3.41 11 7/8" TJI. FLOOR JOISTS @ 16" O.C. R20 BATT OR SPRAY INSULATION 0.12 INTERIOR AIR FILM (H.F. HORIZONTAL)

4.038 EFFECTIVE VALUE INTERIOR WALL
NO RSI REQUIREMENT 1/2" GYPSUM BOARD 2X4 STUDS @ 16" O.C. INSULATION AS PER OWNER

FOR PLUMBING 1/2" GYPSUM BOARD GARAGE TO HOUSE WALL
(RSI 3.08 REQ'D, REFER TO TABLE
A-9.36.2.1 (B) & TABLE 9.36.2.4.1 (D)

PROVIDE 2X6 STUDS WHERE REQ'D

RSI ITEM

0.12 INTERIOR AIR FILM 0.10 5/8" FIRE RATED GYPSUM BOARD 0.108 7/6" OSB SHEATHING

2.66 2X6 STUDS @ 16" O.C. c/w R-24 BATT INSULATION 6 MIL POLY VAPOUR BARRIER
0.08 1/2" GYPSUM BOARD

0.12 INTERIOR AIR FILM 3.19 EFFECTIVE VALUE

FLOOR ASSEMBLY
NO RSI REQUIREMENT FINISH FLOORING AS PER OWNER 3/8" T&G OSB UNDERLAY WHERE REQ'D 3/4" T&G FLOOR SHEATHING 11 7/8" PREMANUFACTURED FLOOR

JOISTS @ 16" O.C. 1/2" PAINTED GYPSUM BOARD BASEMENT SLAB ASSEMBLY
NO RSI REQUIREMENT FINISH FLOORING AS PER OWNER

3 1/2" CONCRETE SLAB C/W
REINFORCING AS REQUIRED
6 MIL POLY VAPOUR BARRIER
COMPACTED GRANULAR FILL
SEAL ALL SLAB PENETRATIONS AND PERIMETER OF SLAB

ROOF ASSEMBLY
(RSI 10.43 REQ'D, REFER TO TABLE
A-9.36.2.6(1b)
RSI ITEM

0.03 EXTERIOR AIR FILM ASPHALT SHINGLES UNDERLAYMENT, EAVE, VALLEY PROTECTION

PROTECTION
7.62 7/16" EXT. ROOF SHEATHING AS PER
2.84 TRUSS MANUFACTURER
12" LOOSE FILL CELLULOSE (R42)
2x6 BOTTOM CHORD @ 26" O.C.
c/w 5.5" LOOSE FILL CELLULOSE (R19)
0.08 6 MIL POLY VAPOUR BARRIER
0.11 1/2" CEILING GYPSUM BOARD
INTERIOR AIR FILM (H.F. UP)

10.68 EFFECTIVE RSI VALÙE

FOWLER§

17 Fleetwood Cr. St. Albert, AB, T8N 1R4 (780)399-7902 josh@fowlerstudio.ca








with 922 sf GARAGE

BASEMENT FLOOR PLAN ISSUED

FOR PERMIT APPLICATION DETAILS

1812 PROJECT NUMBER: 3/16" = 1'-0" SCALE: JULY 25, 2018 DATE: DRAWN BY:

> DRAWING NUMBER **A3**

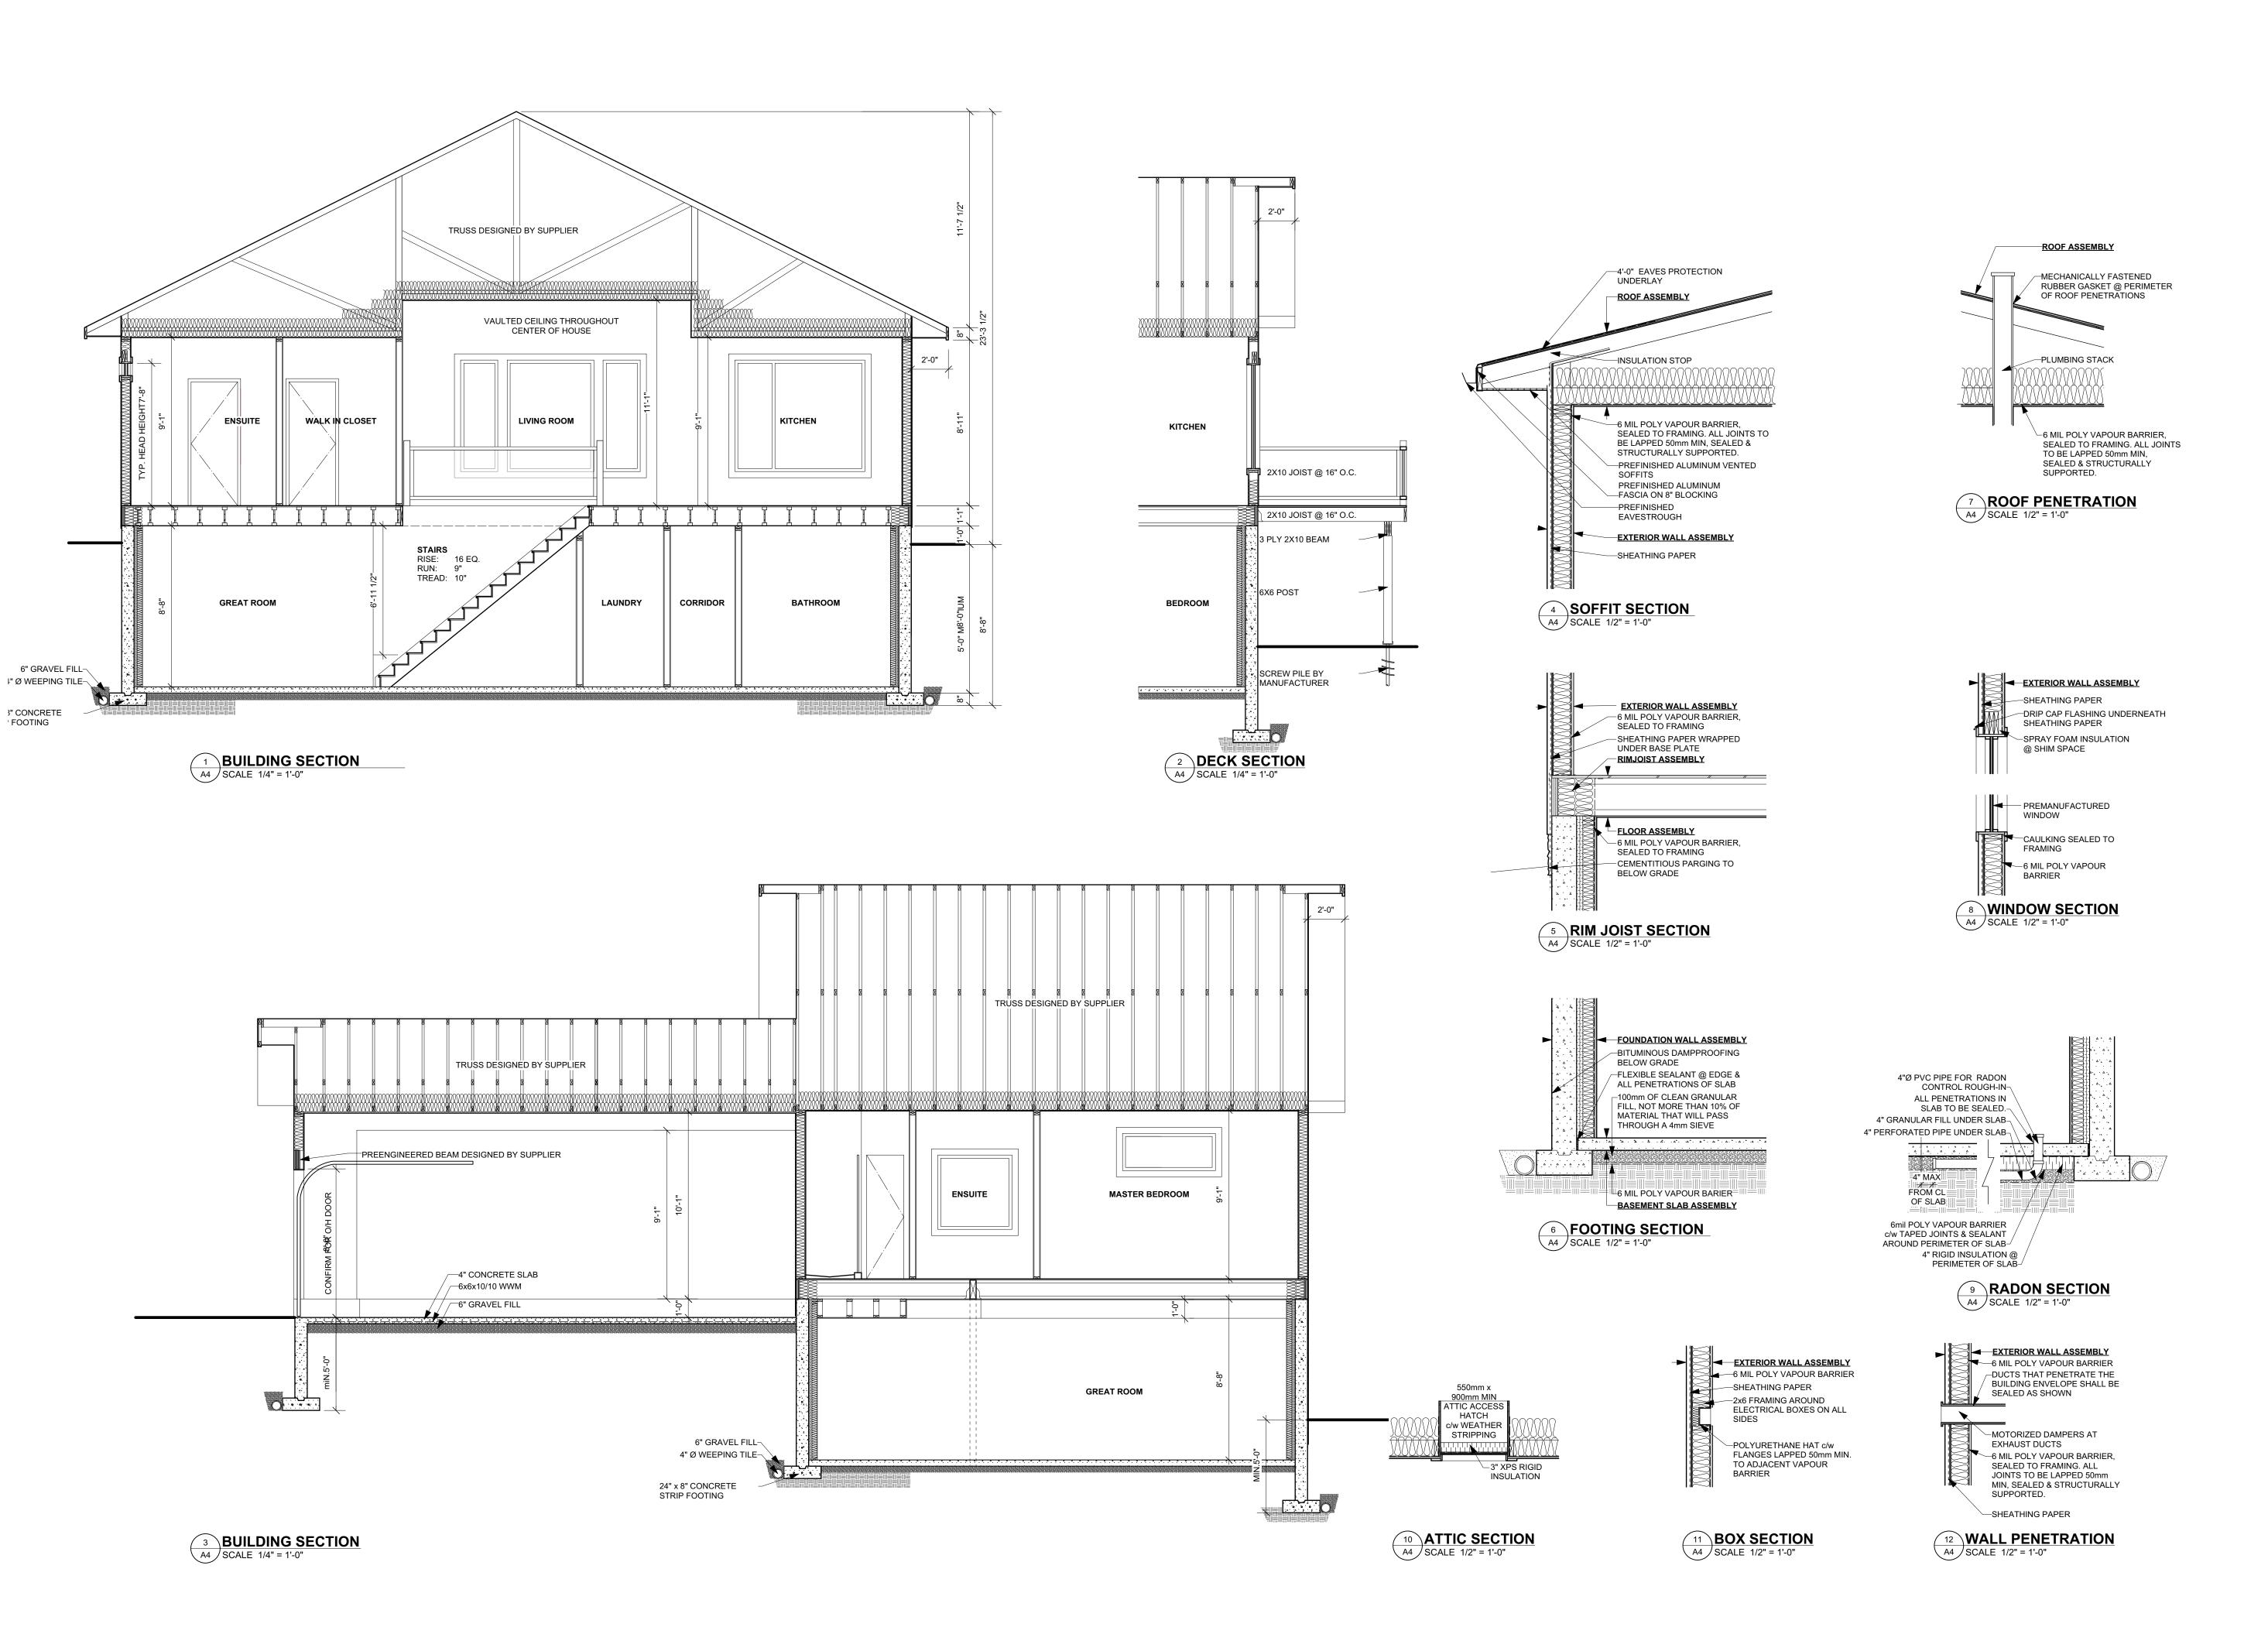

CONSTRUCTION ASSEMBLIES FOUNDATION WALL
(RSI 3.46 REQ'D, REFER TO TABLE A-9.36.2.1 (C) & TABLE 9.36.2.4.1 (D) RSI ITEM

0.081 8" CONCRETE WALL 1.68 2" XPS TYPE 3 INSULATION 1.64 2X4 STUDS @ 16" O.C. C/W R-12 BATT INSULATION 6 MIL POLY VAPOUR BARRIER

0.08 1/2" GYPSUM BOARD 0.12 INTERIOR AIR FILM 3.60 EFFECTIVE VALUE

EXTERIOR WALL
(RSI 3.08 REQ'D, REFER TO TABLE A-9.36.2.1 (B) & TABLE 9.36.2.4.1 (D)

RSI ITEM 0.03 EXTERIOR AIR FILM 0.11 CLADDING SHEATHING PAPER

0.108 7/16" OSB SHEATHING 2.66 2x6 SPF STUDS @ 16" O.C. R-24 BATT NSULATION

6 MIL POLY VAPOUR BARRIER
0.08 1/2" GYPSUM BOARD 0.12 INTERIOR AIR FILM (H.E. HORIZONTAL) 3.11 EFFECTIVE VALUE

RIM BOARD (RSI 3.08 REQ'D, REFER TO TABLE A-9.36.2.1 (B) & TABLE 9.36.2.6(2)

RSI ITEM 0.03 EXTERIOR AIR FILM 0.11 CLADDING

SHEATHING PAPER 0.108 3/8" OSB SHEATHING 6 MIL POLY SHEET 0.26 1 1/4" ENGINEERED RIM JOIST 3.41 11 7/8" TJI. FLOOR JOISTS @ 16" O.C.

R20 BATT OR SPRAY INSULATION 0.12 INTERIOR AIR FILM (H.F. HORIZONTAL) 4.038 EFFECTIVE VALUE

INTERIOR WALL
NO RSI REQUIREMENT 1/2" GYPSUM BOARD 2X4 STUDS @ 16" O.C. INSULATION AS PER OWNER PROVIDE 2X6 STUDS WHERE REQ'D FOR PLUMBING

1/2" GYPSUM BOARD GARAGE TO HOUSE WALL
(RSI 3.08 REQ'D, REFER TO TABLE A-9.36.2.1 (B) & TABLE 9.36.2.4.1 (D)

RSI ITEM 0.12 INTERIOR AIR FILM

0.10 5/8" FIRE RATED GYPSUM BOARD 0.108 7/6" OSB SHEATHING 2.66 2X6 STUDS @ 16" O.C. c/w R-24 BATT INSULATION

6 MIL POLY VAPOUR BARRIER
0.08 1/2" GYPSUM BOARD 0.12 INTERIOR AIR FILM

3.19 EFFECTIVE VALUE

FLOOR ASSEMBLY
NO RSI REQUIREMENT FINISH FLOORING AS PER OWNER 3/8" T&G OSB UNDERLAY WHERE REQ'D 3/4" T&G FLOOR SHEATHING 11 7/8" PREMANUFACTURED FLOOR

JOISTS @ 16" O.C. 1/2" PAINTED GYPSUM BOARD

BASEMENT SLAB ASSEMBLY
NO RSI REQUIREMENT FINISH FLOORING AS PER OWNER 3 1/2" CONCRETE SLAB C/W REINFORCING AS REQUIRED 6 MIL POLY VAPOUR BARRIER COMPACTED GRANULAR FILL SEAL ALL SLAB PENETRATIONS

AND PERIMETER OF SLAB ROOF ASSEMBLY
(RSI 10.43 REQ'D, REFER TO TABLE

A-9.36.2.6(1b) RSI ITEM 0.03 EXTERIOR AIR FILM

ASPHALT SHINGLES UNDERLAYMENT, EAVE, VALLEY PROTECTION

7.62 7/16" EXT. ROOF SHEATHING AS PER 2.84 TRUSS MANUFACTURER 12" LOOSE FILL CELLULOSE (R42) 2x6 BOTTOM CHORD @ 26" O.C.
- c/w 5.5" LOOSE FILL CELLULOSE (R19)
0.08 6 MIL POLY VAPOUR BARRIER
0.11 1/2" CEILING GYPSUM BOARD

INTERIOR AIR FILM (H.F. UP)

10.68 EFFECTIVE RSI VALUE

FOWLER §

17 Fleetwood Cr. St. Albert, AB, T8N 1R4 (780)399-7902 josh@fowlerstudio.ca



PROJECT SPRING LAKE RANCH

THE ASPEN MIRRORED 1575 sf BUNGALOW

with 922 sf GARAGE

BASEMENT FLOOR PLAN ISSUED

FOR PERMIT APPLICATION

DETAILS 1812 PROJECT NUMBER: SCALE: **AS SHOWN** DATE: JULY 25, 2018 DRAWN BY:

DRAWING NUMBER